




DRAWING NO :MIDC/CP/2/1500

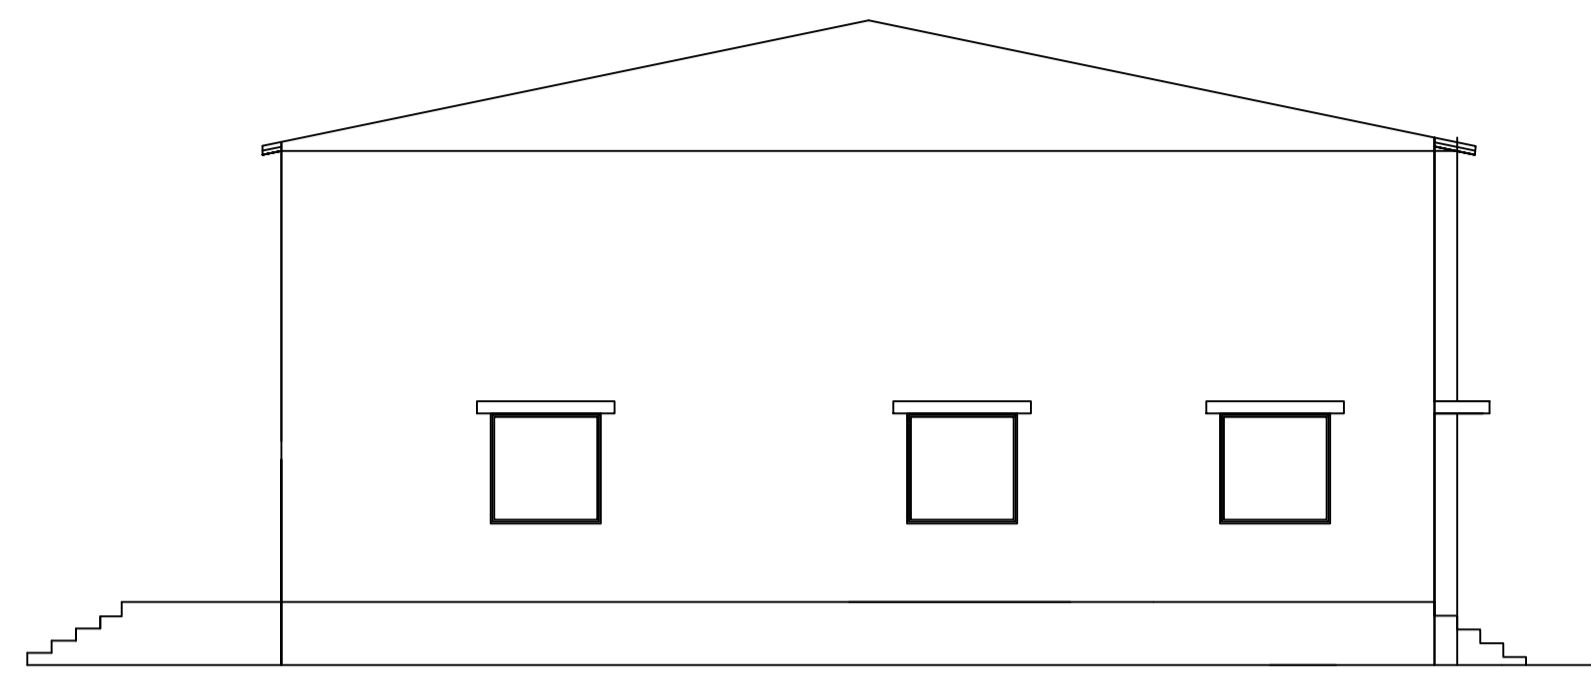


FRONT ELEVATION
SCALE 1:100

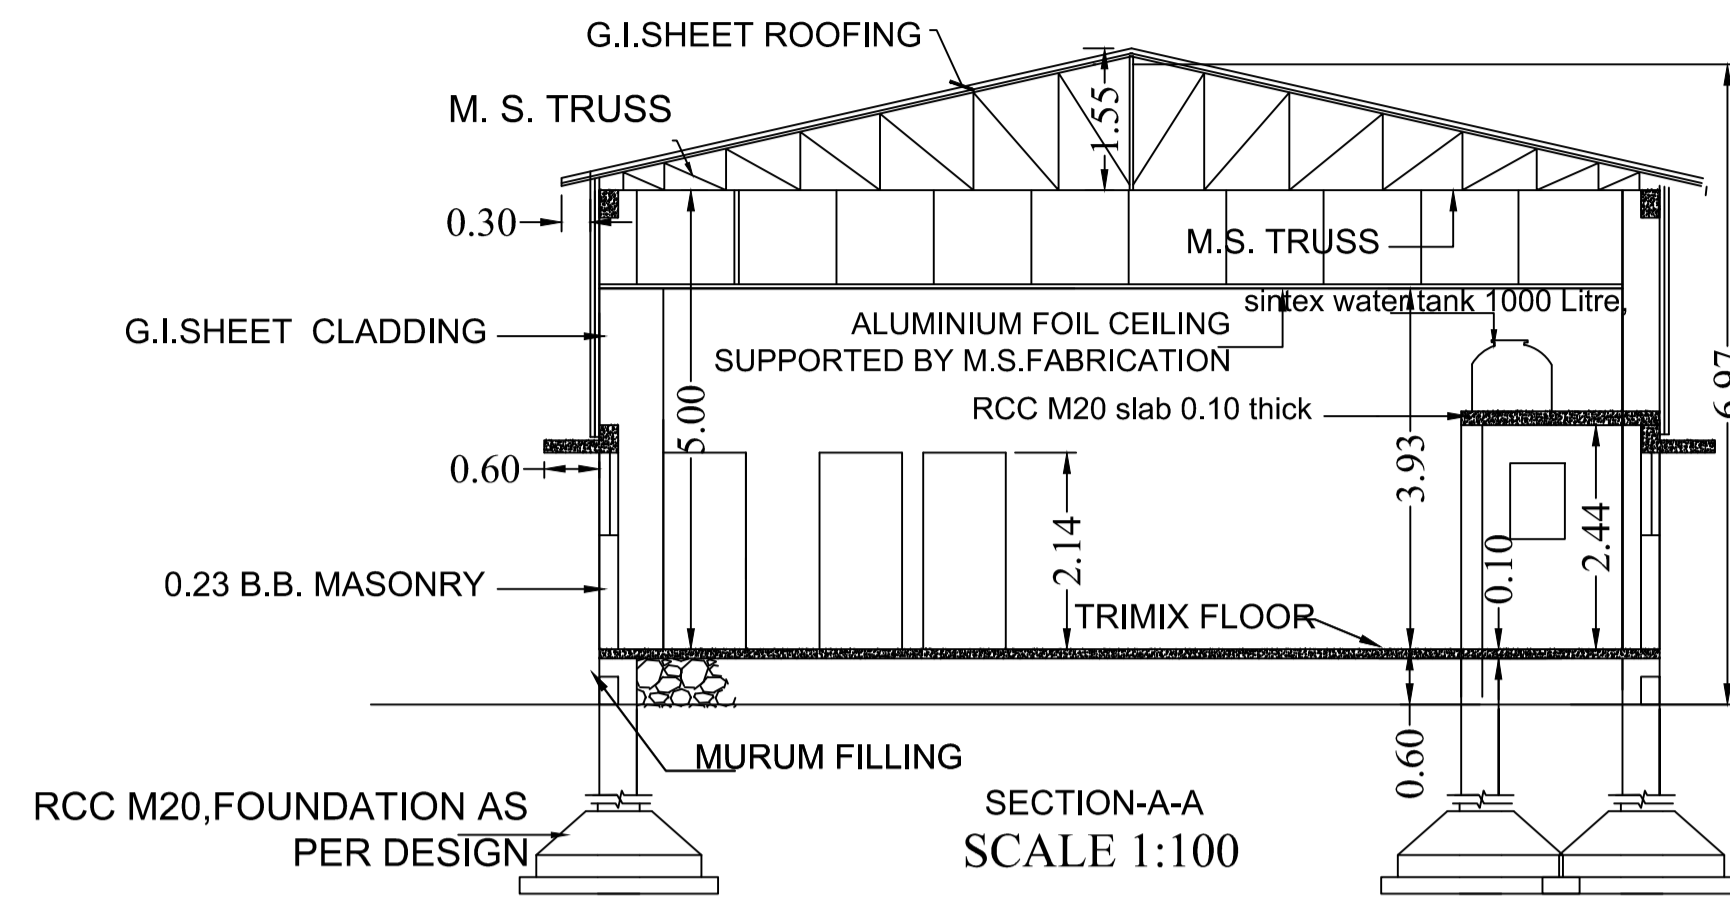


SECTION-A-A
SCALE 1:100

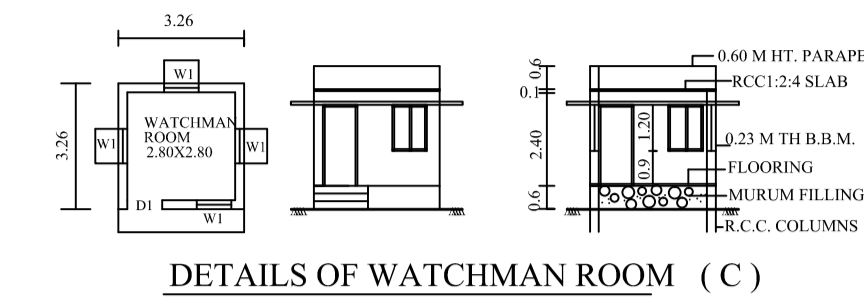


DETAILS OF WATCHMAN ROOM (C)

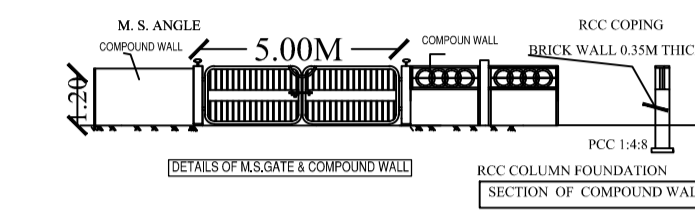


DETAILS OF M.S.GATE & COMPOUND WALL

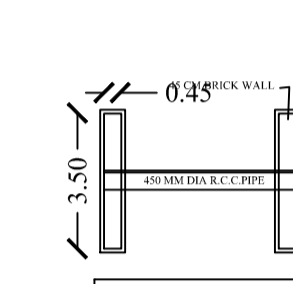


DETAILS OF C.D.WORK

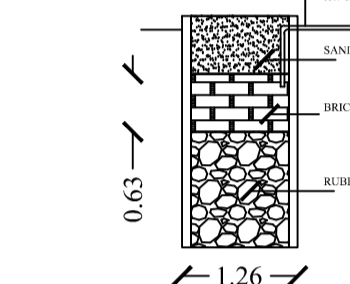


SECTION OF RAIN WATER HARVESTING PIT

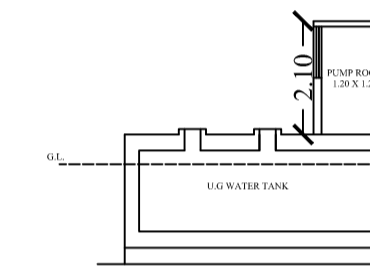


SECTION AT X-X

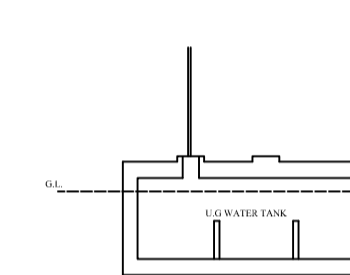

SECTION AT X-X

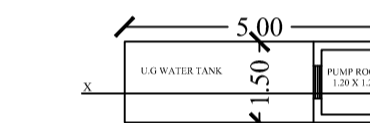


PLAN:UGWT & PUMP ROOM

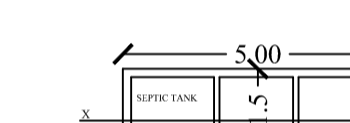


PLAN:SEPTIC TANK

PARKING AREA CALCULATION


FOR 200 SQ M = 1 CAR PARKING
 TOTAL B/U AREA = 300.03 SQ M
 PARKING REQ. = 300.03/200 = 2 CARS
 10% VISITORS PARKING = 1 CARS
 25% PARKING FOR MMR = 1 CARS
 TOTAL PROVIDED PARKING = 4 CARS
 TWO WHEELER PARKING = 1 NOS
 (10% OF CAR PARKING)

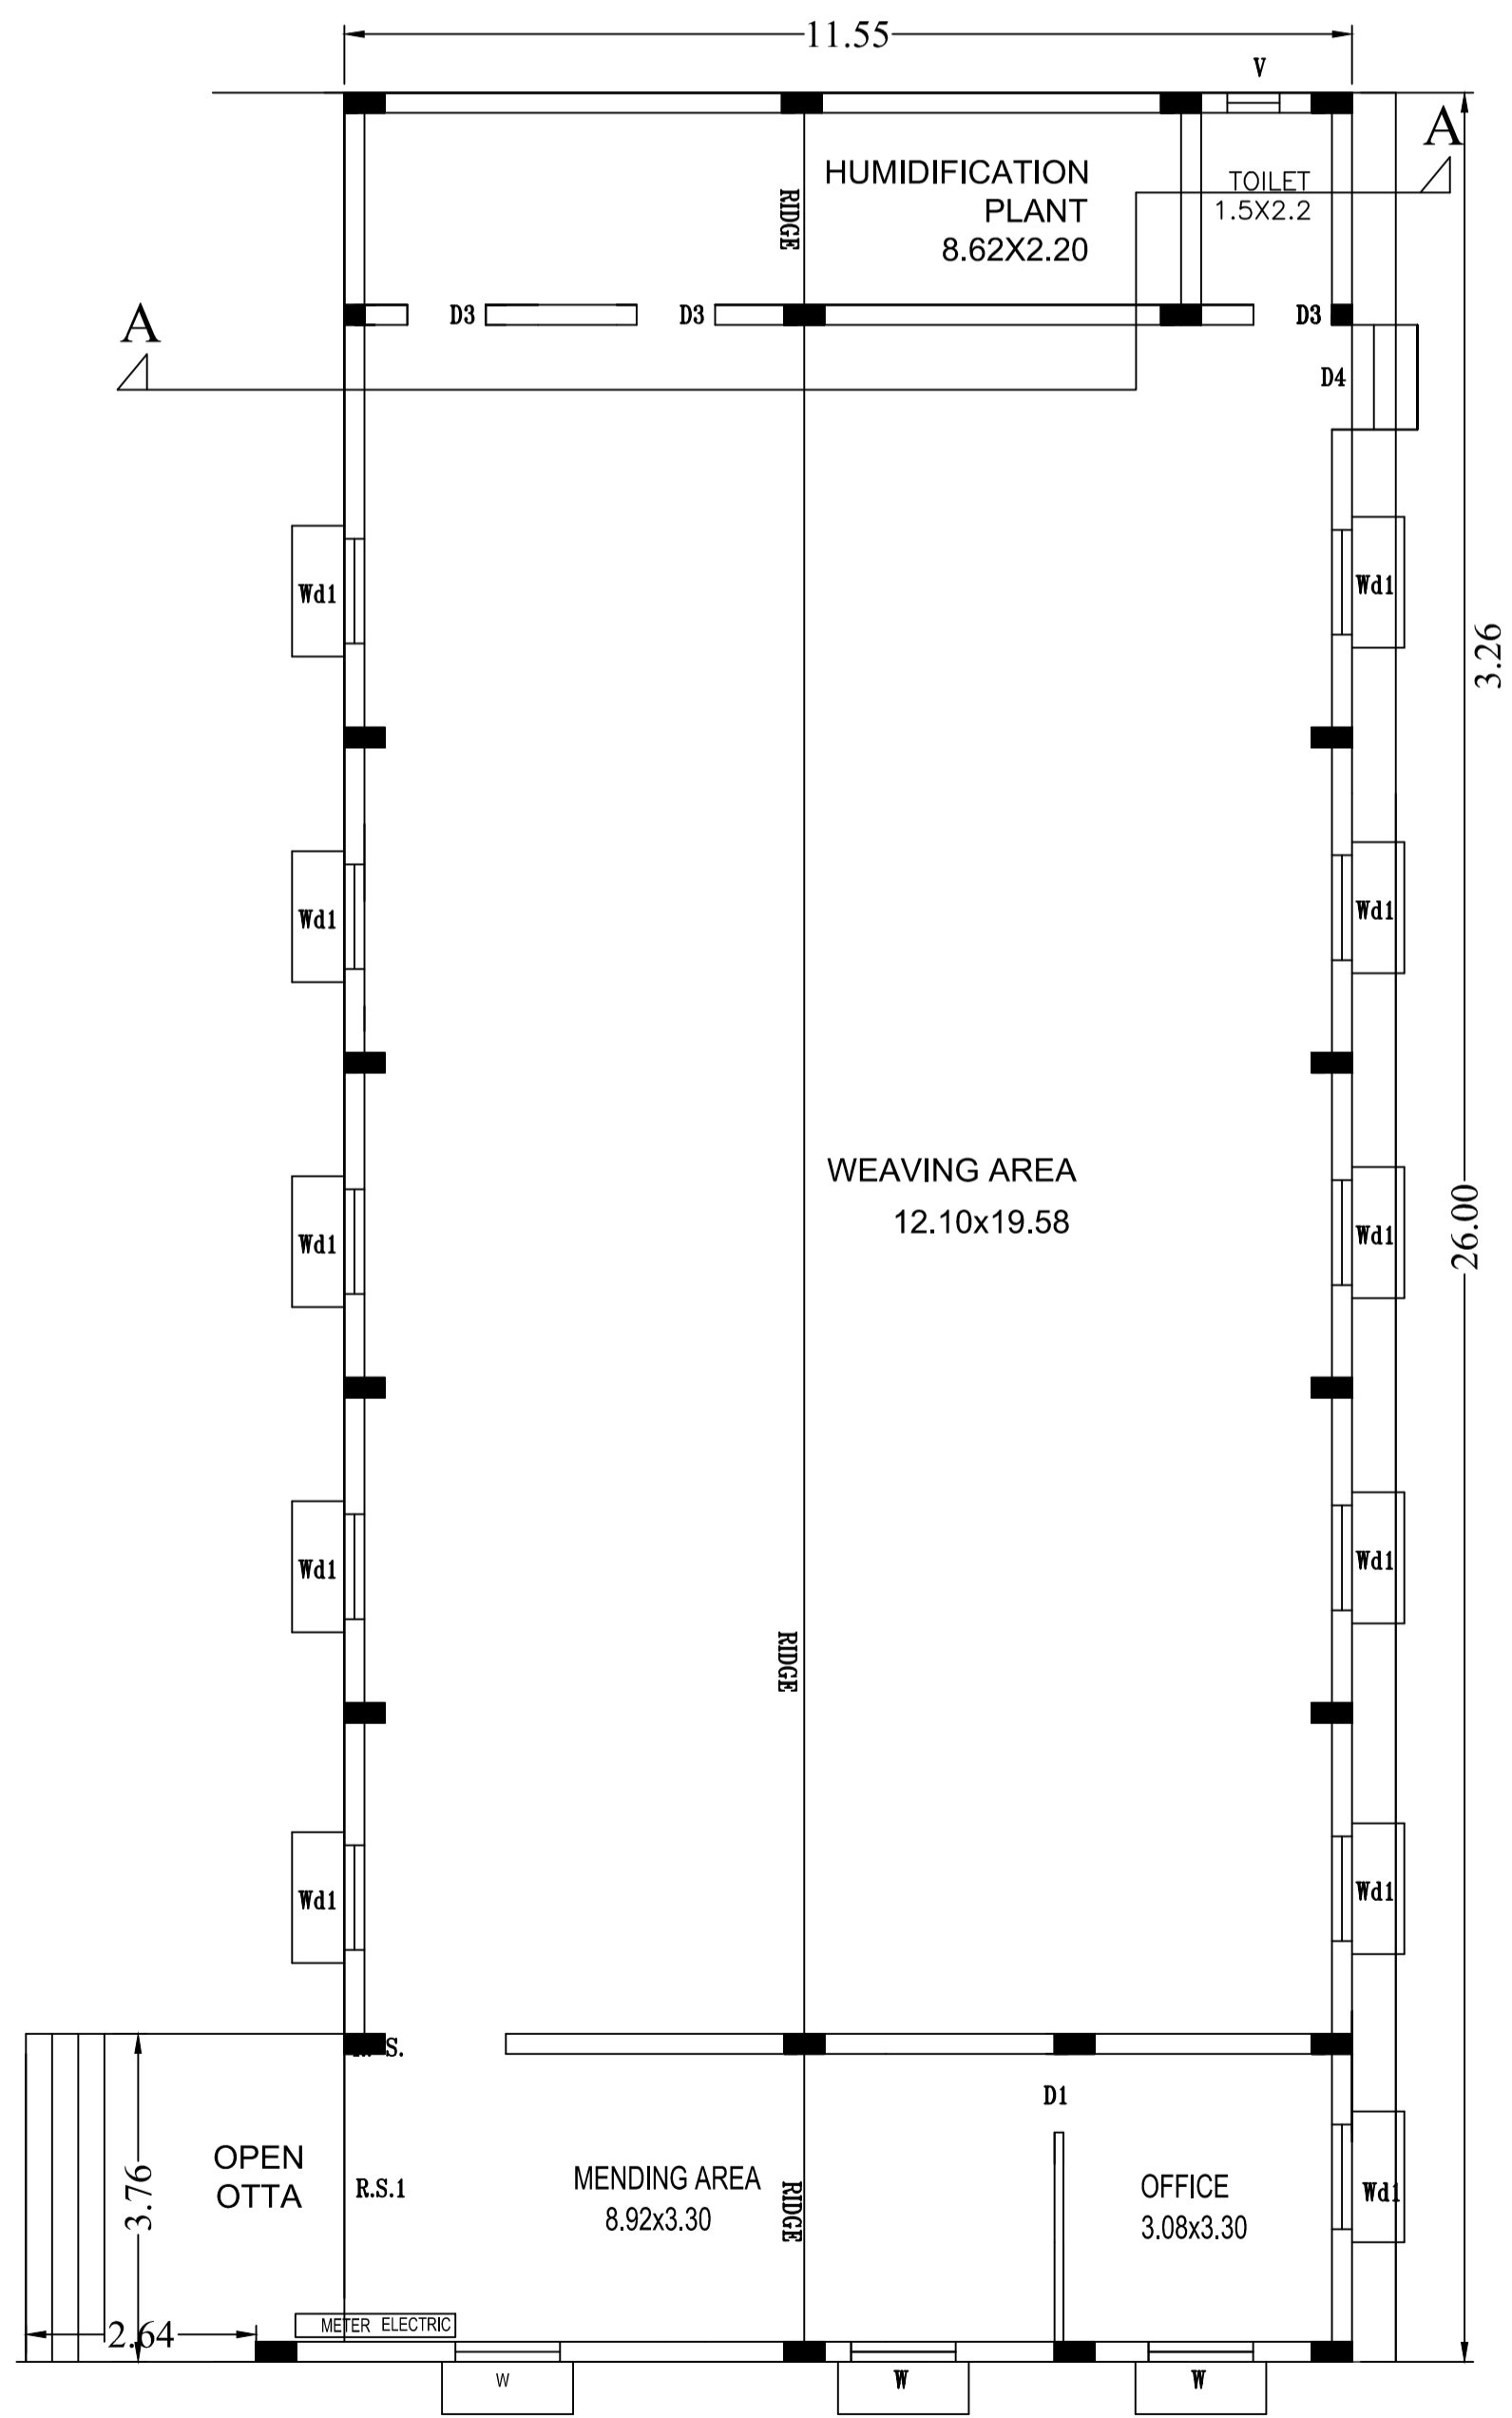

PLAN
SCALE 1:100

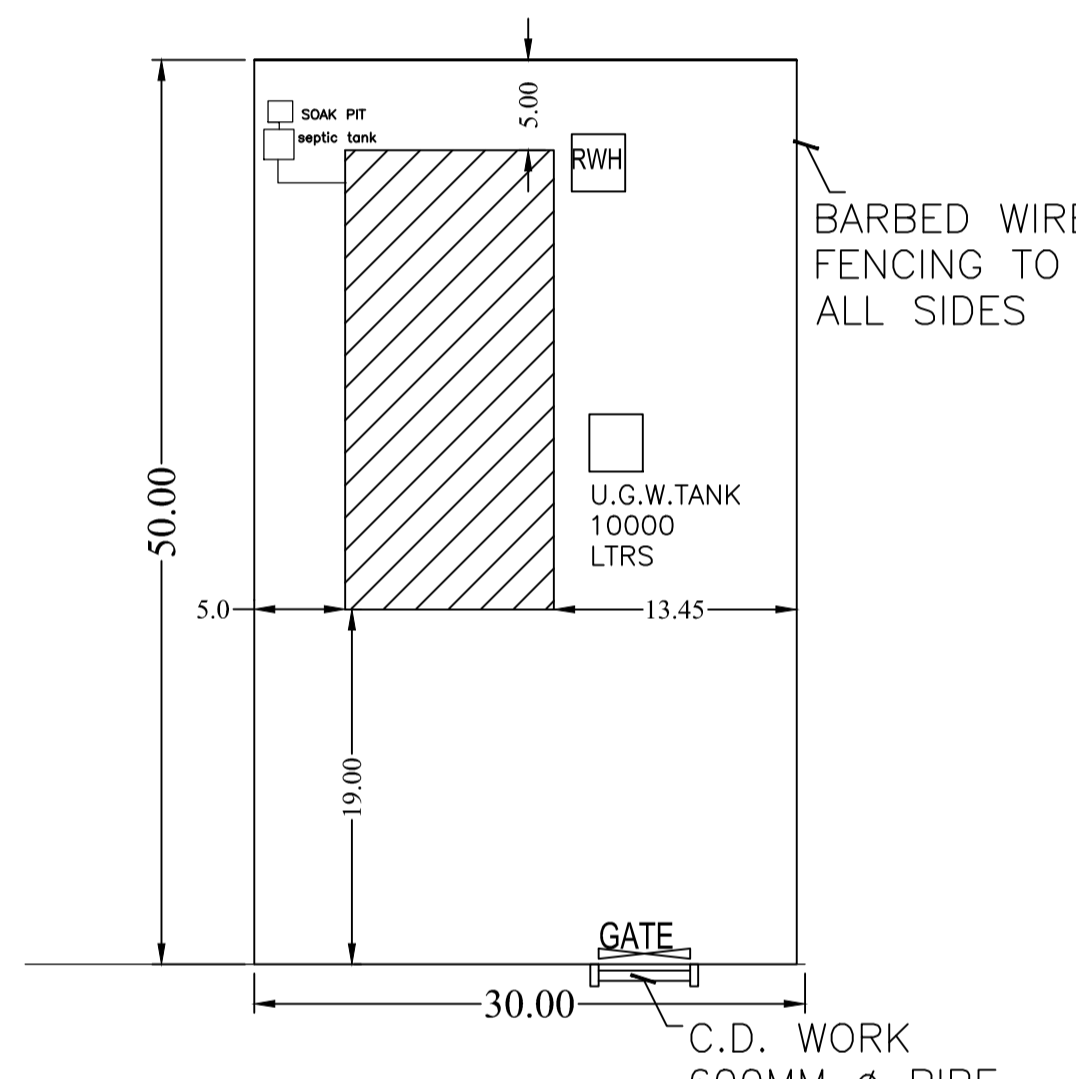

SITE PLAN
SCALE 1:100

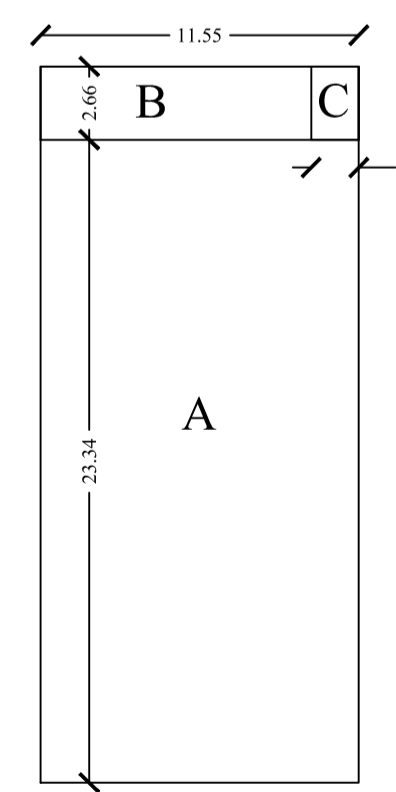

AREA KEY PLAN
SCALE- 1:300

SR.NO	STRUCTURE	CODE	GROUND		EXTRA HEIGHT		TOTAL AREA	
			EXISTING	PROPOSED	EXISTING	PROPOSED	EXISTING	PROPOSED
1	WEAVING AREA	A	269.58	269.58			269.58	269.58
2	HUMIDIFICATION PLANT	B	26.12	26.12			26.12	26.12
3	TOILET	C	4.6	4.6			4.6	4.6
TOTAL BUILT UP AREA			300.3	300.3			300.3	300.3
TOTAL F.S.I CONSUMED								20.00%

SHED AREA CALCULATION

A- WEAVING AREA = 11.55 X 23.34 = 269.58
 B- HUMIDIFICATION PLANT = 9.82 X 2.66 = 26.12

R.C.C AREA CALCULATION

C- TOILET = 1.73 X 2.66 = 4.60
 TOTAL BUILT UP AREA = SHED + R.C.C
 = 295.70 + 4.60
 = 300.30 SQ.M

TOTAL PLOT AREA 1500.00 SQMT.

- A) FACTORY BUILDING @G.F. 300.03 SQMT
- B) WORKING AREA (F.F.) 00.00 SQMT
- C) TOTAL BUILT UP AREA-(GF+FF) 300.03 SQMT.
- D) ADD 50% BUILT UP AREA FOR HIGHT ABOVE 5.0M 00.00SQMT.
- E) TOTAL BUILT UP AREA [C+D] 300.03 SQMT
- F) F.S.I. CONSUMED $\frac{300.03 \text{ SQMT}}{1500.00 \text{ SQMT}} = 0.20$

DETAILS OF DOOR & WINDOWS

	SIZE	PETICULAR
D	1.50 X 2.40	T.W.DOOR
D1	0.75 X 2.10M.	M.S./ T.W. DOOR
D2	0.9 X 2.10M.	M.S./ T.W. DOOR
W1	3.00 X 2.10 M	M.S.GLAZED WINDOW
W	1.50 X 1.20	M.S.GLAZED WINDOWS
V1	1.50 X 0.60	M.S.GLAZED VENTILATOR
RS	4.00 X 2.40	

- 1) PLOT BOUNDARY SHOWN THUS -
- 2) PROPOSED CONSTRUCTION SHOWN THUS -
- 3) BUILDING PERMICATION LINE SHOWN THUS -
- 4) RAIN WATER HARVESTING LINE SHOWN THUS -

OWNER SIGNATURE

MIDC ARCHITECTURE AND TOWN PLANNING DEPARTMENT

CHIEF PLANNER , MIDC